RESIDENTIAL TOWNHOUSE DEVELOPMENT

LOT 188-189 ON RP33870 47–49 NOBLE STREET CLAYFIELD, QLD 4011

DEVELOPMENT APPROVAL No. A005430425

DRAWING INDEX				
DRAWING No.	<u>DESCRIPTION</u>			
20191-C01	LOCALITY PLAN, DRAWING INDEX AND GENERAL NOTES			
20191-EW01	EARTHWORKS AND RETAINING WALL PLAN			
20191-EW02	EARTHWORKS SECTIONS			
20191-R01	FINISHED LEVELS AND VERGE WORKS PLAN			
20191-SW01	STORMWATER DRAINAGE PLAN			
20191-SW02	STORMWATER DRAINAGE LONGITUDINAL SECTION			



LOCALITY PLAN SCALE 1:2500

GENERAL NOTES

- 1. ALL DIMENSIONS ARE IN METRES UNLESS NOTED OTHERWISE.
- ALL TEMPORARY AND PERMANENT SIGNAGE AND LINEMARKING TO BE IN ACCORDANCE WITH MAIN ROADS STANDARDS (MANUAL OF UNIFORM TRAFFIC CONTROL DEVICES).
- 3. ALL DIMENSIONS ARE TO BE CHECKED ON-SITE BEFORE WORK COMMENCES.
- 4. DIMENSIONS SHALL NOT BE OBTAINED BY SCALING THE DRAWING
- 5. DURING CONSTRUCTION BARRIERS, LIGHTS & SIGNS SHALL BE MAINTAINED TO ENSURE SAFE PASSAGE OF TRAFFIC AND PEDESTRIANS IN ACCORDANCE WITH THE REQUIREMENTS OF THE LOCAL AUTHORITY.
- 6. ALL WORKMANSHIP AND MATERIALS SHALL BE IN ACCORDANCE WITH S.A.A. CODES & BY-LAWS AND ORDINANCES OF THE RELEVANT LOCAL AUTHORITY AND WORKPLACE HEALTH AND SAFETY REQUIREMENTS.
- THE CONTRACTOR SHALL BE RESPONSIBLE FOR NOTIFYING ALL RELEVANT
- 8. CONTRACTOR TO VERIFY ALL INVERT LEVELS, SURFACE LEVELS, COVER OVER DRAINAGE LINES, AND MINIMUM FALLS ARE CORRECT & OBTAINABLE PRIOR TO COMMENCEMENT OF WORK.
- 9. THE CONTRACTOR'S ATTENTION IS DRAWN TO THE REQUIREMENTS OF THE THE CONTRACTOR A TERMINON DEAWN TO THE REQUIREMENTS OF THE WORK HEALTH AND SAFETY ACT 2011. ALL WORK IS TO BE CARRIED OUT IN ACCORDANCE WITH THIS ACT AND IN PARTICULAR THE CONTRACTOR TO TO ENSURE THE REQUIREMENTS OF THIS SPECIFICATION WITH REGARD TO "NOTIFICATION IN RELATION TO A NOTIFICATION IN RELATION TO A NOTIFICATION IN RELATION TO A NOTIFICATION IN RELATION."
- 10. CONTRACTOR SHALL VERIFY THE LOCATION OF ALL EXISTING SERVICES CONTRACTOR STRALL VERIFT THE COCKRITOR OF THE CONTRACTOR STRUCTURES AND STRUCTURES ARE TO BE MAINTAINED IN GOOD ORDER FOR THE DURATION OF THE CONTRACT. ANY COST ASSOCIATED WITH REPAIRING DAMAGE TO
- THE PERSON RESPONSIBLE FOR THE DEMOLITION WORKS SHALL ENSURE THAT ALL VEHICLES LEAVING THE SITE CARRYING DEMOLITION MATERIALS HAVE THEIR LOADS COVERED AND DO NOT TRACK SOIL OR WASTE MATERIALS ONTO THE ROAD.
- 12. SHOULD ASBESTOS BE PRESENT. ITS REMOVAL SHALL BE CARRIED OUT IN ACCORDANCE WITH THE NATIONAL OH&S COMMITTEE - CODE OF PRACTICE FOR SAFE REMOVAL OF ASBESTOS AND ITS CODE OF PRACTICE FOR THE MANAGEMENT AND CONTROL OF ASBESTOS IN THE WORKPLACE.







HCE Engineers Hydraulīc • Cīvīl • Envīronmental

Phone: (07) 3829 1399

47-49 NOBLE STREET CLAYFIELD QLD 4011 LOTS 188-189 RP33870

PROJECT

LOCALITY PLAN, DRAWING INDEX AND GENERAL NOTES

TITLE

HOMA GROUP

SIGNATURE NAME GREG HENWOOD RPEQ 5317 DATE 22.09.20


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TM 16/09/20 A005430425 AS SHOWN

20191-C01

SCALE 1:2500 (A1)

(SCALE BEFORE REDUCTION)

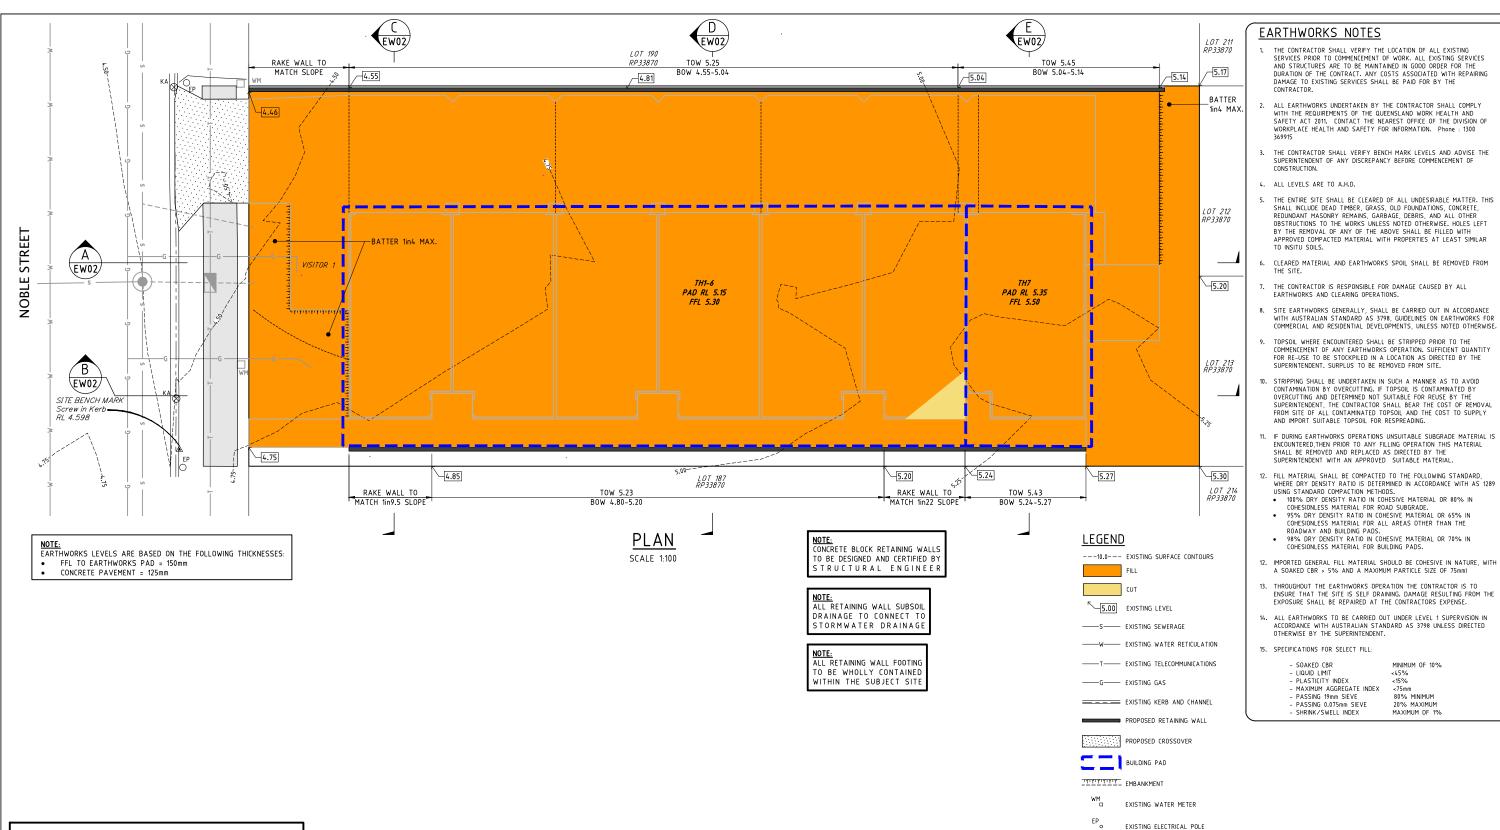

CLIENT

HOMA GROUP

CERTIFIC ATION

BRISBANE CITY COUNCIL STANDARD: ALL RETAINING WALLS INCLUDING FOOTINGS MUST BE LOCATED WHOLLY WITHIN THE PROPERTY BOUNDARY OF THE SITE WHERE WORKS ARE OCCURRING. RETAINING WALLS TO STABILISE EXCAVATION MUST BE SET BACK OFF THE PROPERTY BOUNDARIES TO ACCOMMODATE SUBSOIL DRAINAGE WITHOUT ENCROACHMENT INTO THE NEIGHBOURING PROPERTY. THIS SET BACK MAY VARY DEPENDING ON THE HEIGHT, STRUCTURE AND DESIGN OF THE RETAINING WALL, INCLUDING LOADINGS FROM NEIGHBOURING PROPERTIES, AND TO PROVIDE A SURFACE DRAIN ALONG THE TOP OF THE RETAINING WALL

THIS DESIGN HAS BEEN PREPARED BASED ON SERVICE AUTHORITY AS CONSTRUCTED INFORMATION. NO POT HOLING HAS BEEN UNDERTAKEN TO VERIFY EXISTING SERVICE LOCATIONS AND DEPTHS. IT IS THE CONTRACTORS RESPONSIBILITY TO UNDERTAKE POT HOLING TO VERIFY THE DESIGN.

SCALE 1:100 (A1) (SCALE BEFORE REDUCTION)

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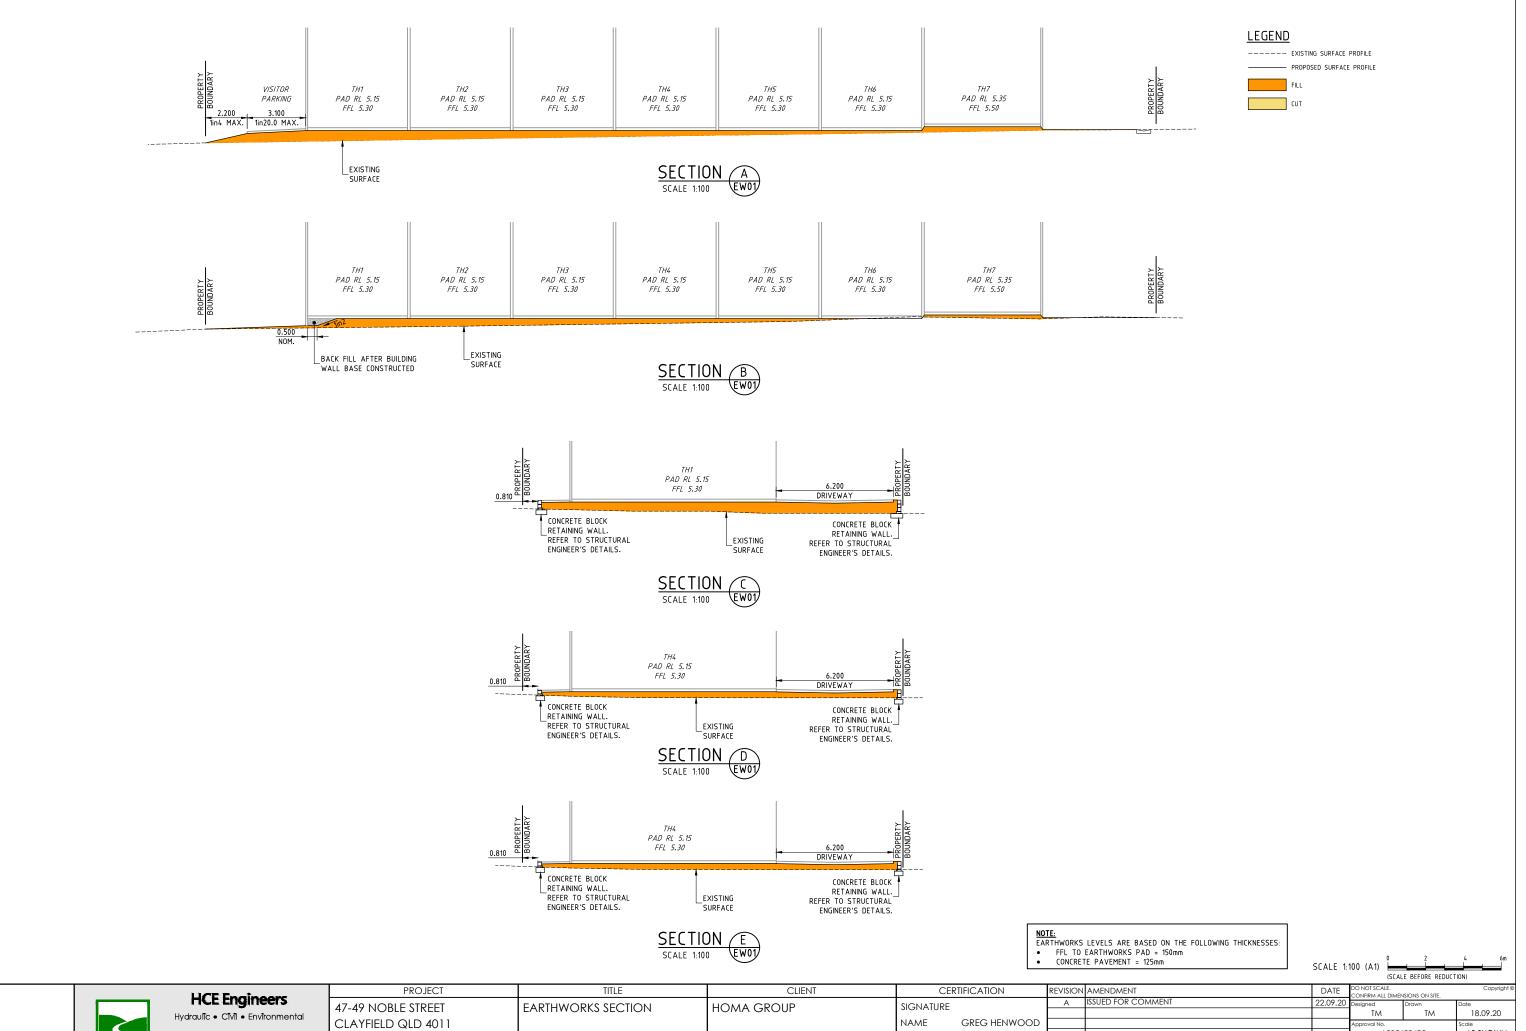
P.O Box 7214, Phone: (07) 3829 1399 Redland Bay, mail@hce-engineers.com.au QLD, 4165 6 Marine Street, Redland Bay

47-49 NO	BLE STREET
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LOTS 188-	189 RP3387


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IOBLE STREET	EARTHWORKS AND
ELD QLD 4011	RETAINING WALL PLAN
38-189 RP33870	

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SIGNATURE		Α	ISSUED FOR COMMENT	22.09.20	Designed	Drawn
JIONATORE					TM	TM
NAME	GREG HENWOOD				Approval No.	
RPEQ	5317				A0054	130425
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DATE	22.09.20				20	191-EW01

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A005430425 AS SHOWN P.O Box 7214, Phone: (07) 3829 1399 Redland Bay, mail@hce-engineers.com.au QLD, 4165 6 Marine Street, Redland Bay RPEQ 5317 LOTS 188-189 RP33870 DATE 22.09.20 20191-EW02



CLIENT

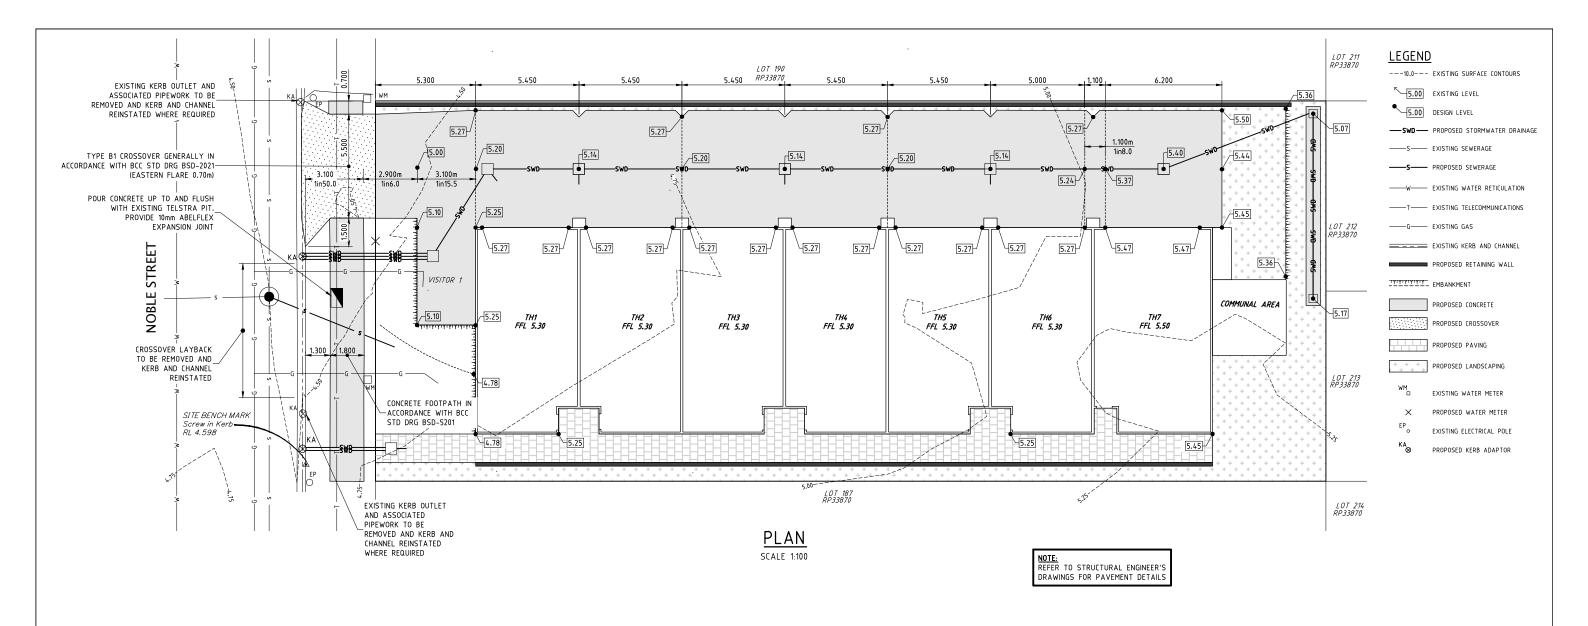HOMA GROUP

THIS DESIGN HAS BEEN PREPARED BASED ON SERVICE AUTHORITY AS CONSTRUCTED INFORMATION. NO POT HOLING HAS BEEN UNDERTAKEN TO VERIFY EXISTING SERVICE LOCATIONS AND DEPTHS. IT IS THE CONTRACTORS RESPONSIBILITY TO UNDERTAKE POT HOLING TO VERIFY THE DESIGN.

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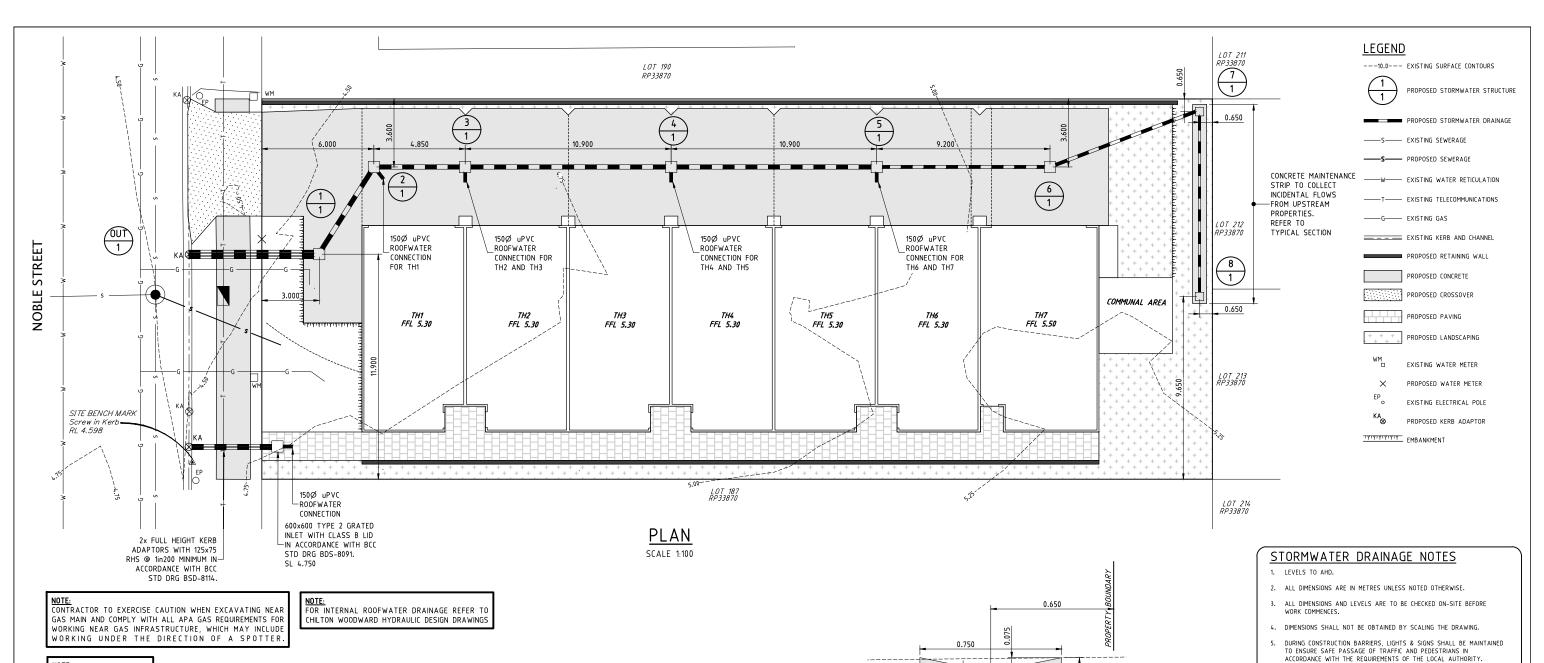
PROJECT

TITLE	
FINISHED LEVELS AND	
VERGE WORKS PLAN	

SIGNATURE		Α	ISSUED FOR COMMENT	22.09.20	Dε
SICI W CICKL					ı
NAME	GREG HENWOOD				Αį
RPEQ	5317				
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DATE	22.09.20				

REVISION AMENDMENT

CERTIFICATION



NOTE: ALL DISTURBED AREAS TO BE REINSTATED TO THEIR

ORIGINAL CONDITION

NOTE: CONTRACTOR TO REMOVE ANY REDUNDANT DRAINAGE OUTLETS FROM THE KERB & CHANNEL INCLUDING ANY ASSOCIATED PIPE WORK ACROSS THE FOOTWAY AND REINSTATE THE KERB AND CHANNEL AND THE FOOTWAY

CONCRETE SWALE. 600mm WIDE 125mm MIN. THICK
N25 CONCRETE MAINTENANCE— └-125x75 RHS STRIP REINFORCED WITH SL72 MESH (3 WIRES LONGITUDINALLY).

CONCRETE STRIP TYPICAL SECTION

- 6. ALL WORK AND MATERIALS SHALL BE IN ACCORDANCE WITH LOCAL AUTHORITY CURRENT SPECIFICATIONS AND STANDARDS.
- ALL WORKMANSHIP AND MATERIALS SHALL BE IN ACCORDANCE WITH S.A.A. CODES & BY-LAWS AND ORDINANCES OF THE RELEVANT LOCAL AUTHORITY AND WORKPLACE HEALTH AND SAFETY REQUIREMENTS.
- 8. THE CONTRACTOR SHALL BE RESPONSIBLE FOR NOTIFYING ALL RELEVANT AUTHORITIES AND PAYING ALL FEES NECESSARY BEFORE COMMENCING WORK, FOR LOCATING ALL EXISTING SERVICES AND FOR REPAIR OF ANY SERVICES DAMAGED AS A RESULT OF THE WORKS.
- 9. THE CONTRACTOR'S ATTENTION IS DRAWN TO THE REQUIREMENTS OF THE WORKPLACE HEALTH AND SAFETY ACT 1995. ALL WORK IS TO BE CARRIED DUT IN ACCORDANCE WITH THIS ACT AND IN PARTICULAR THE CONTRACTOR IS TO ENSURE THE REQUIREMENTS OF THIS SPECIFICATION WITH RECARD TO 'NOTIFICATION IN RELATION TO A NOTIFIABLE PROJECT, ARE FORFILLED.
- PIPES SHALL NOT BE LAID WITHIN THE ZONE OF INFLUENCE OF STRUCTURAL LOADINGS UNLESS BRIDGING OF THE LOAD IS PROVIDED. ANY BRIDGING IS TO BE DESIGNED BY A RPEQ.
- 11. BENCHING OF PIT STRUCTURES SHALL HAVE A SMOOTH FINISHED SURFACE, AND PIPES SHALL NOT PROJECT INSIDE THE SHAFT OF THE PIT.
- 12. FOLLOWING STORMS. THE ROAD RESERVE AND SEDIMENT BARRIERS ARE TO BE INSPECTED AND ALL SEDIMENT RESIDUES ARE TO BE REMOVED.
- 13. OPEN PIPES AND GULLY PITS DURING CONSTRUCTION ARE TO BE CAPPED OR PLUGGED (SOLID OR FILTER CLOTH) AT THE END OF EACH DAYS WORK.
- 14. ROAD EFFECTED BY WORKS ARE TO BE KEPT CLEAN. MATERIAL IS TO BE SWEPT FROM ROAD SURFACE.
- 15. REPAIR ANY DAMAGE TO EXISTING KERB AND CHANNEL, FOOTPATH OR

ROADWAY THAT MAY OCCUR DURING ANY WORKS CARRIED OUT WITH THE APPROVED DEVELOPMENT.





POT HOLING TO VERIFY THE DESIGN.

THIS DESIGN HAS BEEN PREPARED BASED ON SERVICE AUTHORITY

AS CONSTRUCTED INFORMATION. NO POT HOLING HAS BEEN UNDERTAKEN TO VERIFY EXISTING SERVICE LOCATIONS AND DEPTHS. IT IS THE CONTRACTORS RESPONSIBILITY TO UNDERTAKE

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FROJECT
47-49 NOBLE STREET
CLAYFIELD QLD 401
LOTS 188-189 RP3387

TITLE STORMWATER DRAINAGE PLAN HOMA GROUP 370


CERTIFICATION					
SIGNATURE					
NAME	GREG HENWOOL				
RPEQ	5317				
DATE	22.09.20				

CLIENT

SCALE 1:100 (A1) (SCALE BEFORE REDUCTION) (SCALE BEFORE REDUCTION)

REVISION AMENDMENT ISSUED FOR COMMENT 22.09.2 TM 18.09.20 CIC A005430425 AS SHOWN 20191-SW01

SCALE 1:10 (A1)

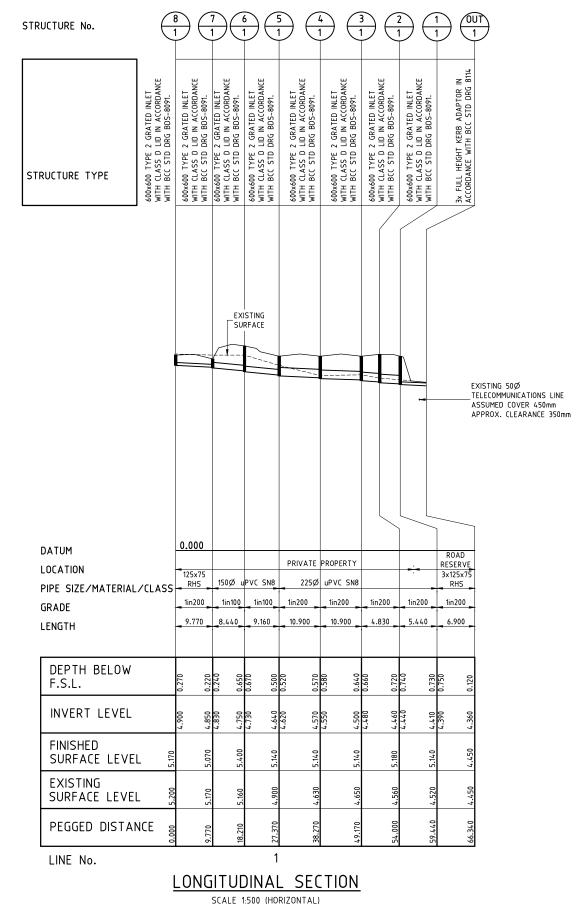

THIS DESIGN HAS BEEN PREPARED BASED ON SERVICE AUTHORITY AS CONSTRUCTED INFORMATION. NO POT HOLING HAS BEEN UNDERTAKEN TO VERIFY EXISTING SERVICE LOCATIONS AND DEPTHS. IT IS THE CONTRACTORS RESPONSIBILITY TO UNDERTAKE POT HOLING TO VERIFY THE DESIGN.


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Hydraulīc • Cīvīl • Envīronmental	CLAYFIELD QLD 4011	LONGITUDINAL SECTION		NAME	GREG HENWOOD				Approval No.	TM	18.09.20 Scale	
P.O Box 7214, Phone: (07) 3829 1399 Redland Bay, mail@hce-engineers.com.au	LOTS 188-189 RP33870			RPEQ	5317				A005	5430425	AS SHOW	٧N
QLD, 4165 6 Marine Street, Redland Bay				DATE	22.09.20			 	20	0191-SW02	kev.	A



RESIDENTIAL TOWNHOUSE DEVELOPMENT LOTS 188–189 ON RP33870 47-49 NOBLE STREET, CLAYFIELD, QLD 4011, 20-PNT-47499

DRAWING INDEX				
DRAWING No.	<u>DESCRIPTION</u>			
20191-501	SEWERAGE LOCALITY PLAN, DRAWING INDEX AND GENERAL NOTES			
20191-502	SEWERAGE RETICULATION PLAN			



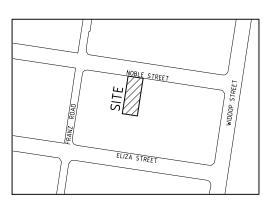

LOCALITY PLAN

NAME OF ESTATE		47-49 NOBLE STREET
		CLAYFIELD
SUBDIVIDER		QUU
APPLICATIO	N NO.	20-PNT-47499
SP DELEGA	TE	URBAN UTILITIES
APPROVAL	DATE	17.09.20
DRAWING/PLAN NO.		
No. OF ALL	OTS.	1
AREA IN ho		0.5
LENGTH	DN110	
OF SEWER	DN160	7.140m
	DN250	
REFERENCE		,

HOUSE CONNECTIONS HAVE BEEN DESIGNED TO CONTROL ALL OF THE LOT AT A GRADE OF 1:100

IT IS THE DEVELOPERS RESPONSIBILITY TO ENGAGE A STRUCTURAL ENGINEER (RPEQ) TO ENSURE THE STRUCTURAL INTEGRITY OF THE EXISTING BUILDING AND ITS FOUNDATIONS, PRIOR TO, DURING AND AFTER THE CONSTRUCTION OF SEWER. ANY RECTIFICATION WORK TO BE AT THE DEVELOPERS EXPENSE.

TM 16/09/20

INITIALS DATE

GH

THESE WORKS ARE CONSIDERED MINOR WORKS AND WORKS ARE T BE CONSTRUCTED BY A PRIVATE CONTRACTOR, INSPECTIONS ARE TO BE ARRANGED BY CONTACTING THE ENDORSED MINOR WATER AND SEWER PROVIDER IDENTIFIED ON THIS PLAN (HCF ENGINEERS), FOR AS CONSTRUCTED PLANS THE CONTRACTOR IS TO CONTACT HOE ENGINEERS (3829 1399) 7 DAYS PRIOR TO THE WORKS COMMENCING

SEWER NOTES

GENERAL

- ALL CONSTRUCTION WORK SHALL COMPLY WITH THE REQUIREMENTS OF THE QUEENSLAND WORK HEALTH AND SAFETY ACT 2011. CONTACT THE DIVISION OF WORKPLACE HEALTH AND SAFETY FOR INFORMATION BY PHONE ON 1300 362 128.
- ALL WORK AND MATERIALS SHALL BE IN ACCORDANCE WITH CURRENT GRAVITY SEWERAGE CODE OF AUSTRALIA - SEQ EDITION STANDARDS AND URBAN UTILITIES ADDITIONAL REQUIREMENTS
- UNLESS SPECIFIED OTHERWISE, ALL MATERIALS AND WORK SHALL COMPLY WITH THE RELEVANT AUSTRALIAN STANDARDS
- THE CONSTRUCTION OF THE SEWERAGE WORK SHOWN ON THIS DRAWING SHALL BE SUPERVISED BY AN ENGINEER WHO HAS RPEQ REGISTRATION. SEWERAGE WORKS NOT COMPLYING WITH THIS REQUIREMENT WILL NOT BE PERMITTED TO CONNECT INTO URBAN UTILITIES SEWERAGE SYSTEM
 - ALL LEVELS TO A.H.D.
- CLEARANCES TO OTHER SERVICES TO BE IN ACCORDANCE WITH TABLE 5.4 OF THE SEQ GRAVITY SEWERAGE CODE OF AUSTRALIA SPECIFICATIONS UNLESS NOTED OTHERWISE. HORIZONTAL TOLERANCES TO BE +/- 100mm LATERAL DISPLACEMENT FROM THE DESIGN ALIGNMENT
- FOR SEWER MAINS AND PROPERTY SERVICES
- ALL SEWER LENGTHS AND GRADES ARE MEASURED FROM CENTRE OF MAINTENANCE HOLE/SHAFT UNO.

EXISTING FEATURES

- CONTRACTOR SHALL BE RESPONSIBLE FOR VERIFYING THE LOCATION AND DEPTH OF EXISTING
- IF FXISTING CONCRETE PATHWAYS/DRIVEWAYS NEED TO BE MODIFIED OR CUT. FULL WIDTH PANELS OF PATHWAYS/DRIVEWAYS BETWEEN EXISTING JOINTS ARE TO BE REMOVED, NO PATHWAYS/DRIVEWAYS TO BE CUT LONGITUDINALLY IN HALF OR OTHER PART THEREOF. REINSTATEMENT TO BE IN ACCORDANCE WITH THE RELEVANT AUTHORITY STANDARD DRAWINGS FOR FOOTPATHS AND DRIVEWAYS. WHEN MAINTENANCE STRUCTURES NEED TO BE INSTALLED WITHIN COUNCIL CONCRETE FOOTPATHS, LOCALISED REINSTATEMENT OF IMMEDIATE FITTING SURROUND IS NOT PERMITTED. NEW CONCRETE PANELS SHALL BE PROVIDED IN ACCORDANCE WITH THE RELEVANT AUTHORITY STANDARD DRAWINGS, WITH NEW AND EXISTING JOINTS SPACING NO LESS THAN 1m

PERMITS

- PRIOR TO THE COMMENCEMENT OF WORK, THE CONTRACTOR SHALL ARRANGE FOR ROAD OPENING AND TRAFFIC PERMITS FROM THE RELEVANT AUTHORITIES. WORK MAY BE REQUIRED TO BE CARRIED OUT DURING WEEKENDS AND / OR LATE AT NIGHT ONLY.
- CONTRACTOR IS RESPONSIBLE FOR OBTAINING ANY NECESSARY PERMITS ASSOCIATED WITH VEGETATION REMOVAL /MANAGEMENT

CONSTRUCTION NOTES

- ALL PIPES AND MATERIALS SHALL COMPLY WITH THE REQUIREMENTS OF THE "ACCEPTED CIVIL PRODUCTS AND MATERIALS LIST".
- EACH ALLOTMENT SHALL BE SERVED BY A DN110 PROPERTY CONNECTION. FOR ALLOTMENTS OTHER THAN SINGLE RESIDENTIAL A DN160 PROPERTY CONNECTION SHALL BE PROVIDED. A MAXIMUM OF 2 RESIDENTIAL PREMISES IS ALLOWED ON A DN110. PROPERTY CONNECTION SEWER DETAILS SHALL COMPLY WITH THE DETAILS GIVEN IN GRAVITY SEWERAGE CODE OF AUSTRALIA - SEQ EDITION STANDARD DRAWINGS SEQ-SEW-1106-1 TO 1106-6.
- PROPERTY CONNECTIONS JUNCTIONS SHALL BE LOCATED 1.20m FROM THE DOWNSTREAM ALIGNMENT. IF THIS IS NOT POSSIBLE PROPERTY CONNECTION JUNCTIONS SHALL NOT BE GREATER THAN 3.50m FROM THE DOWNSTREAM ALIGNMENT.
- PROPERTY CONNECTION BRANCHES SHALL EXTEND INTO THE PROPERTY A MINIMUM OF 300mm AND A MAXIMUM OF 750mm.
- WHERE PROPERTY CONNECTION IS IN A DRIVEWAY, PROVIDE A 1mx1m REMOVABLE CONCRETE SLAB WITH SUITABLE LIFTING LUGS CENTRALLY OVER THE CONNECTION AS REQUIRED UNDER THE URBAN UTILITIES "BUILD OVER ASSETS" POLICY.
- WHERE PIPES ARE LAID IN FILL, THE FILLING SHALL BE CARRIED OUT IN LAYERS NOT EXCEEDING 300mm (LOOSE) IN DEPTH AND SHALL BE COMPACTED UNTIL THE COMPACTION IS NOT LESS THAN 95% OF THE MATERIALS MAXIMUM COMPACTION WHEN TESTED IN ACCORDANCE WITH AS 1289 (MODIFIED COMPACTION). TESTING SHALL BE CARRIED OUT AFTER EACH ALTERNATE LAYER. IN ALL SUCH CASES APPROVAL OF CONSTRUCTED SEWERS WILL NOT BE ISSUED BY THE COUNCIL UNLESS CERTIFICATES ARE PROVIDED CERTIFYING THAT THE REQUIRED COMPACTION HAS BEEN ACHIEVED. PE SEWERS SHALL BE INSTALL IN ACCORDANCE WITH THE REQUIREMENTS FOR NON-PRESSURE PIPELINES SPECIFIED IN WSA POLYETHYLENE PIPELINE CODE.
- WHERE SEWERS HAVE A GRADE OF 1 IN 20 OR STEEPER, BULK HEADS SHALL BE CONSTRUCTED IN ACCORDANCE WITH CL.9.10 OF GRAVITY SEWERAGE CODE OF AUSTRALIA SEQ EDITION.
- SEWERS SHALL BE DISUSED/ABANDONED IN ACCORDANCE WITH PROCEDURES SET OUT IN CL.5.2.9 OF GRAVITY SEWERAGE CODE OF AUSTRALIA -SEO EDITION.
- EMBEDMENT AND TRENCHING TO BE 'TYPE 4' UNLESS NOTED OTHERWISE IN ACCORDANCE WITH THE GRAVITY SEWERAGE CODE OF AUSTRALIA - SEQ EDITION STD DRG SEQ-SEW-1201-1.
- CONSTRUCT BULKHEADS AND TRENCH STOPS TO SEQ-SEW-1206-1 AND TRENCH DRAINS TO
- CONSTRUCT MHs TO SEQ-SEW-1301-1, 1301-2 AND -3 (TYPE G), 1301-4 AND -5 (TYPE F), 1301-6, -8, -10, -11 (TYPE X) 1304-1, 1305-1, 1307-4 (STUB CUT-IN), 1313-1 (CONNECTION) AND 1502-1 (INSERTION MH AND REPAIR SYSTEM), 1301-12 (LADDERS).
- 24. CONSTRUCT MAINTENANCE SHAFTS AND TERMINAL ENTRY POINT TO SEQ-SEW-1315-1 AND 1316-1 AND
- INSTALL MH/MS TYPE B COVERS TO SEQ-SEW-1308-2 TO 1308-7 INSTALL MH/MS TYPE D COVERS TO SEQ-SEW-1308-8 TO 1308-11.
- CONSTRUCT PROPERTY CONNECTIONS TO SEQ-SEW-1106-1 TO 1106-6
- INSTALL DETECTABLE MARKER TAPE ON ALL SEWER MAINS AND PROPERTY CONNECTIONS. NEW MANHOLES THAT MEET ANY ONE OR MORE OF THE FOLLOWING CONDITIONS SHALL BE PE LINED:
- THE MH IS A RECEIVING MH FOR A SEWER RISING MAIN OR WITHIN 100m OF SUCH A RECEIVING
- THE MH IS THE COLLECTION MH IMMEDIATELY UPSTREAM OF A SEWAGE PUMPING STATION.
- THE MH HAS AN INTERNAL DIAMETER OF 1500mm OR MORE.

 THE MH EXCEEDS 4m DEPTH TO THE INVERT OF ITS OUTLET SEWER.
- THE OUTFLOW SEWER FROM THE MH HAS A DIAMETER GREATER THAN 300mm.
- THE MH IS SERVICING AN INDUSTRIAL AREA.
- WHERE AN ASSESSMENT OF CORROSION OR ODOUR HAS INDICATED PROTECTION IS REQUIRED.
- 30. CONCRETE FOR MH CONSTRUCTION SHALL BE SPECIAL CLASS TO WSA PS-358 WITH REQUIREMENT FOR CALCAREOUS AGGREGATE.

SOIL CLASSIFICATION

- THE CONTRACTOR SHALL ASSESS SOIL CONDITIONS TO DETERMINE CLASSIFICATION IN ACCORDANCE WITH SED-SEW-1200-1
- 32. IF THE CONTRACTOR ENCOUNTERS SOIL IN TRENCHES WITH AN ALLOWABLE BEARING PRESSURE OF LESS THAN 50kPa. THEY SHALL IMMEDIATELY CONTACT THE RPEQ AND AWAIT DIRECTION.

TESTING AND CONNECTING

- ALL SEWERS AND MAINTENANCE STRUCTURES SHALL BE INSPECTED BY CCTV. THE FIRST CCTV INSPECTION SHALL BE MADE PRIOR TO COMMISSIONING AFTER ALL BACKFILLING OPERATIONS HAVE BEEN SATISFACTORILY COMPLETED AND ALL JUNCTIONS HAVE BEEN INSTALLED.
- A SECOND CCTV INSPECTION IS REQUIRED PRIOR TO BUT NOT MORE THAN 2 WEEKS BEFORE. THE ON-SITE INSPECTION FOR OFF-MAINTENANCE CERTIFICATION.
- CCTV EQUIPMENT IN ACCORDANCE WITH SECTION 21.8 OF THE GRAVITY SEWERAGE CODE OF AUSTRALIA AND THE WSAA CONDUIT INSPECTION REPORTING CODE OF AUSTRALIA WSA05 AND THE RESULTS SUBMITTED TO URBAN UTILITIES FOR COMPLIANCE CHECKING
- TESTING AND QA REQUIREMENTS SHALL BE UNDERTAKEN IN ACCORDANCE WITH GRAVITY SEWERAGE CODE OF AUSTRALIA.
- VACUUM / PRESSURE TESTING AS PER SECTION 21.1. ON ALL NEW MAINS, STRUCTURES, PROPERTY SERVICES 12m OR GREATER IN LENGTH.
- CCTV FOOTAGE AND REPORT FOR ALL SEWER MAINS AND ALL PROPERTY SERVICES THAT ARE 12m
- OR GREATER. TO BE SUBMITTED AS PER SEQ CODE FORMAT AND REQUIREMENTS.
 CONCRETE DELIVERY DOCKETS FOR ALL CONCRETE USED AS PART OF MANHOLES.
- 40. COMPACTION TEST RESULTS FOR ALL NEW SEWER MAINS AND PROPERTY SERVICES CROSSING ROADS IN ACCORDANCE WITH SECTION 21.3 OF GRAVITY SEWERAGE CODE OF AUSTRALIA.

 • FREQUENCY - TRAFFICABLE AREAS - ONE TEST IN EACH 300mm LAYER OF FILL FOR EACH 50
 - LINEAL METRES OF SEWER OR PART THEREOF. THE ROAD OWNER MAY SPECIFY ADDITIONAL COMPACTION TESTING REQUIREMENTS.
 - FREQUENCY NON-TRAFFICABLE AREAS ONE TEST IN EACH 900mm LAYER OF FILL FOR EACH 100 LINEAL METRES OF SEWER OR PART THEREOF
- FREQUENCY FOR MAINTENANCE AND INSPECTION STRUCTURES ONE TEST WITHIN EACH 1m DEPTH AT ONE LOCATION WITHIN 300mm OF EACH.
- RE-FILLING OF "EXCESSIVE EXCAVATION" TO BE IN ACCORDANCE WITH SECTION 14.9. CONTRACTOR SHALL SEEK SITE SPECIFIC DIRECTION FROM THE CERTIFYING CONSULTING ENGINEER IF DEPTH AND WIDTH OF EXCAVATION EXCEEDS THOSE SPECIFIED IN SECTION 22 - TOLERANCES ON AS CONSTRUCTED WORK.

MISCELLANEOUS

IT IS THE CONTRACTORS RESPONSIBILITY TO CONTACT 'DIAL BEFORE YOU DIG' PH.1100 FOR THE LOCATION OF EXISTING PUBLIC UTILITIES PRIOR TO EXCAVATION. ANY DAMAGE CAUSED TO EXISTING PUBLIC UTILITIES BY THE CONTRACTOR WILL BE REPAIRED BY THE RELEVANT AUTHORITY AT THE CONTRACTORS EXPENSE

REHABILITATION

47. ALL DISTURBED AREAS TO BE REINSTATED TO THEIR ORIGINAL CONDITION

VEGETATION PROTECTION

- 48. TREES LOCATED ALONG THE FOOTPATH SHALL BE TRANSPLANTED PRIOR TO CONSTRUCTION OR REPLACED IF DESTROYED.
- WHEN WORKING WITHIN 4m OF TREES, RUBBER OR HARDWOOD, GIRDLES SHALL BE CONSTRUCTED WITH 18m BATTENS CLOSELY SPACED AND ARRANGED VERTICALLY FROM GROUND LEVEL GIRDLES MUST BE STRAPPED TO TREES PRIOR TO CONSTRUCTION AND REMAIN UNTIL COMPLETION.
- TREE ROOTS SHALL BE TUNNELLED UNDER, RATHER THAN SEVERED. IF ROOTS ARE SEVERED THE DAMAGED AREA SHALL BE TREATED WITH A SUITABLE FUNGICIDE. CONTACT RELEVANT ARBORIST
- 51. ANY TREE LOPPING REQUIRED SHALL BE UNDERTAKEN BY AN APPROVED ARBORIST.

CONTRACTOR ACCREDITATION

- DURING ANY CONSTRUCTION ACTIVITY AT LEAST ONE PERSON ON SITE MUST HAVE COMPLETED A PIPE LAYING TRAINING COURSE APPROVED BY THE PIPE SUPPLIER OR MANUFACTURER AND APPROPRIATE TO THE PIPELINE UNDER CONSTRUCTION. THE TRAINING COURSE MUST HAVE BEEN COMPLETED WITHIN THE LAST TEN YEARS.
- ALL SITE AND FACTORY PE WELDING SHALL BE CARRIED OUT BY A PERSON WHO HAS COMPLETED RELEVANT NATIONALLY ACCREDITED TRAINING COURSES FOR BUTT WELDING/ELECTROFUSION AND HOLD A VALID WELDING CERTIFICATION IN ACCORDANCE WITH AUSTRALIA/NEW ZEALAND AND
- THE CONTRACTOR SHALL PROVIDE DOCUMENTED EVIDENCE OF ACCEPTABLE QUALIFICATIONS.

- ALL LIVE WORKS SHALL BE UNDERTAKEN IN ACCORDANCE WITH A VALID NETWORK ACCESS PERMIT. ALL LIVE WORKS SHALL COMPLY WITH THE NETWORK ACCESS PERMIT CONDITIONS.
 ALL WORK ON EXISTING SEWER, TO BE CARRIED OUT BY THE CONTRACTOR UNDER URBAN UTILITIES
- SUPERVISION, AT THE DEVELOPERS EXPENSE,
- LIVE WORKS MAY NOT COMMENCE UNTIL ALL RELEVANT TEST CERTIFICATES HAVE BEEN PROVIDED TO AND ACCEPTED BY URBAN UTILITIES, AND ALL ADJOINING WORKS HAVE BEEN ACCEPTED BY URBAN

58. CONTRACTOR TO ENSURE CURRENCY OF STANDARDS AT TIME OF CONSTRUCTION.

CERTIFICATION SCHEME ENDORSED CONSULTANT (PLANS SUBMITTED ARE TO URBAN UTILITIES STANDARDS AND SATISFY THE WATER APPROVAL CONDITIONS; WATER APPROVAL REFERENCE NUMBER 20-PNT-47499 ENDORSED CONSULTANT...HCE ENGINEERS NOMINATED RPEQ: GREG HENWOOD RPEQ NO. 5317 DATE. 22.09.20 RPEQ SIGNATURE .. RPEQ CONTACT DETAILS..07. 3829. 1399.

SCALE 1:100 (A1)

Urban Utilities

AS SHOWN SHEET 1 OF

47-49 NOBLE STREET, CLAYFIELD LOT 188-189 ON RP33870 SEWERAGE LOCALITY PLAN, DRAWING INDEX AND GENERAL NOTES DRAWING NO. 20191-S01

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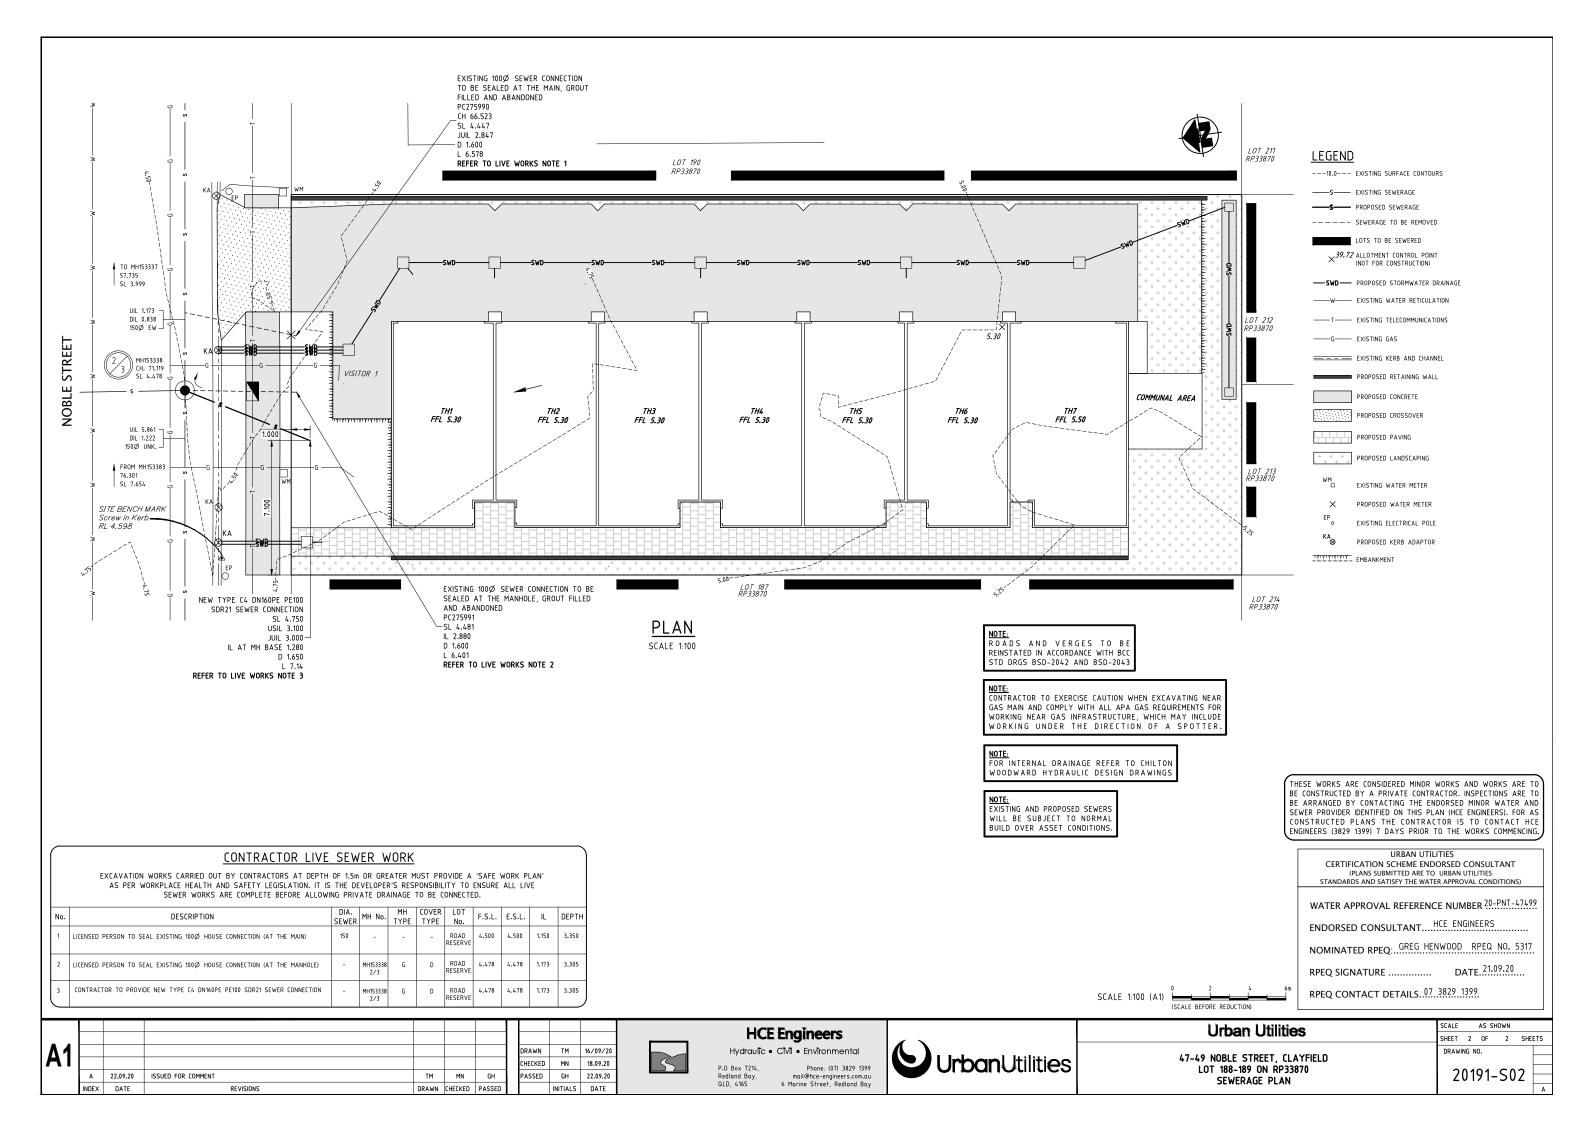
Phone: (07) 3829 1399 6 Marine Street, Redland Bay

HCE Engineers

P.O Box 7214


QLD. 4165





RESIDENTIAL TOWNHOUSE DEVELOPMENT LOTS 188–189 ON RP33870 47–49 NOBLE STREET, CLAYFIELD, QLD 4011, 20-PNT-47501

<u>DRAWING INDEX</u>						
DRAWING No.	<u>DESCRIPTION</u>					
20191-W01	WATER LOCALITY PLAN, DRAWING INDEX AND GENERAL NOTES					
20191-W02	WATER RETICULATION PLAN					

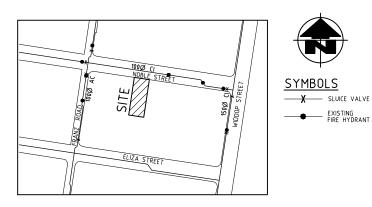

LOCALITY PLAN

WATER RETICULATION NOTES

GENERAL

- ALL CONSTRUCTION WORK SHALL COMPLY WITH THE REQUIREMENTS OF THE QUEENSLAND WORK HEALTH AND SAFETY ACT 2011. CONTACT THE DIVISION OF WORKPLACE HEALTH AND SAFETY FOR INFORMATION BY PHONE ON 1300 362 128.
- 2. ALL WORK AND MATERIALS SHALL BE IN ACCORDANCE WITH THE CURRENT SEQ WATER SUPPLY CODE, URBAN UTILITIES ACCEPTED PRODUCTS AND MATERIALS LIST (IPAM LIST) AND URBAN UTILITIES ADDITIONAL REQUIREMENTS.
- 3. UNLESS SPECIFIED OTHERWISE, ALL MATERIALS AND WORK SHALL COMPLY WITH THE RELEVANT AUSTRALIAN STANDARDS.
- 4. CONSTRUCTION OF THE WATER RETICULATION WORK SHOWN ON THIS DRAWING MUST BE SUPERVISED BY AN ENGINEER WHO HAS RPEQ REGISTRATION. WORKS NOT COMPLYING WITH THIS REQUIREMENT WILL NOT BE PERMITTED TO CONNECT INTO URBAN UTILITIES RETICULATION SYSTEM
- . ADOPT LIP OF KERB OR SHOULDER OF ROAD AS PERMANENT LEVEL
- CLEARANCES TO OTHER SERVICES TO BE IN ACCORDANCE WITH TABLE 5.5 OF THE SEQ WATER SUPPLY CODE SPECIFICATIONS UNLESS NOTED OTHERWISE.
- HORIZONTAL TOLERANCES TO BE +/- 100mm LATERAL DISPLACEMENT FROM THE DESIGN ALIGNMENT FOR WATER MAINS, PROPERTY SERVICES AND WATER METERS.
- 8. ENERGEX PILLARS ARE TO BE 1.10m MINIMUM CLEAR OF WATER METERS AND HYDRANTS.

EXISTING FEATURES

- CONTRACTOR SHALL BE RESPONSIBLE FOR VERIFYING THE LOCATION AND DEPTH OF EXISTING SERVICES PRIOR TO COMMENCING WORKS.
- O. IF EXISTING CONCRETE PATHWAYS/DRIVEWAYS NEED TO BE MODIFIED OR CUT, FULL WIDTH PANELS OF PATHWAYS/DRIVEWAYS BETWEEN EXISTING JOINTS ARE TO BE REMOVED, NO PATHWAYS/DRIVEWAYS TO BE CUT LONGITUDINALLY IN HALF OR OTHER PART THEREOF. REINSTATEMENT TO BE IN ACCORDANCE WITH THE RELEVANT AUTHORITY STANDARD DRAWINGS FOR FOOTPATHS AND DRIVEWAYS. WHEN VALVE OR HYDRANTS NEED TO BE INSTALLED WITHIN COUNCIL CONCRETE FOOTPATHS, LOCALISED REINSTATEMENT OF IMMEDIATE FITTING SURROUND IS NOT PERMITTED. NEW CONCRETE PANELS SHALL BE PROVIDED IN ACCORDANCE WITH THE RELEVANT AUTHORITY STANDARD DRAWINGS, WITH NEW AND EXISTING JOINTS SPACING NO LESS THAN 1 METRE.

PERMITS

- 11. PRIOR TO THE COMMENCEMENT OF WORK THE CONTRACTOR SHALL ARRANGE FOR ROAD OPENING AND TRAFFIC PERMITS FROM THE RELEVANT AUTHORITIES. WORK MAY BE REQUIRED TO BE CARRIED OUT DURING WEEKENDS AND / OR LATE AT NIGHT ONLY.
- CONTRACTOR IS RESPONSIBLE FOR OBTAINING ANY NECESSARY PERMITS ASSOCIATED WITH VEGETATION REMOVAL/MANAGEMENT.

PIPE WORKS

- 13. CONSTRUCT EMBEDMENT AND TRENCHFILL TO SEQ-WAT-1200-2, SEQ-WAT-1201-1 TO SEQ-WAT-1204-1 (TYPE D) SUPPORT UNLESS GEOTECHNICAL INVESTIGATIONS DEMONSTRATE THAT TYPE C SUPPORT IS ADEQUATE AND RELEVANT AUTHORITY OR QUEENSLAND GOVERNMENT DEPARTMENT OF TRANSPORT AND MAIN ROADS STANDARDS FOR ROADWAY CROSSINGS, WHICHEVER IS MORE ONEROUS.
- PROVIDE BULKHEADS/TRENCHSTOPS IN ACCORDANCE WITH SEQ WATER SUPPLY CODE TABLE 7.5 AND SEQ-WAT-1209-1 AND 1210-1.
- CONSTRUCT THRUST BLOCKS ON ALL VALVES, BENDS, TEES, TAPERS, DEAD ENDS, AND TRANSITIONS TO UNRESTRAINED PIPEWORK TO SEQ-WAT-1205-1 AND 1206-1.
- 16. INSTALL DETECTABLE MARKER TAPE ON ALL WATER MAINS AND PROPERTY SERVICES.
- CONSTRUCT FIRE HYDRANTS AND STOP VALVES TO SEQ-WAT-1301-1, 1302-1, 1303-2, 1305-1, 1306-1 AND 1409-1.
- 18. CONSTRUCT SCOURS TO SEQ-WAT-1307-2 WHERE NECESSARY. SCOURS WITHIN IPSWICH CITY COUNCIL REGION MUST DISCHARGE INTO AN OPEN STORMWATER GULLY PIT, NOT TO THE INVERT OF KERB AND CHANNEL. DISCHARGE TO KERB AND CHANNEL VIA A STANDARD KERB ADAPTOR THROUGH THE FACE OF THE KERB IS NOT ACCEPTED BY URBAN UTILITIES
- 316SS BACKING RINGS SHALL BE USED WITH FULL-FACE PE FLANGES. PE STUB-FLANGES ARE NOT ACCEPTED.
- 20. COVER ON MAINS FROM PERMANENT LEVEL TO BE AS SHOWN ON STD DRG SEQ-WAT-1200-2
- 21. FLANGED JOINTS SHALL NOT BE ENCASED IN CONCRETE
- 22. SCL UNDER OTHER SERVICES SHALL BE CONCRETE ENCASED WITH MINIMUM 150mm THICK CONCRETE ENCASEMENT, WITH A FURTHER MINIMUM 150mm (300mm DESIRABLE) CLEARANCE TO SERVICES. SERVICES WITH DEPTH TO INVERT OVER 1.50m SHALL BE FULLY CONCRETE ENCASED. CONCRETE ENCASEMENT SHALL STOP NOMINALLY 300mm BEFORE FLANGES TO ALLOW FOR MAINTENANCE ACCESS.
- SCL WORK SHALL BE UNDERTAKEN BY A LICENSED CONTRACTOR EXPERIENCED IN WELDING OF PRESSURE PIPELINES. CONTRACTOR ACCREDITATION SHALL BE PROVIDED.
- 24. PROVIDE A TEST POINT AT EACH END OF THE SCL SERVICE CROSSING
- PROTECTION METHODS TO ELECTRICAL INFRASTRUCTURE SHALL INCORPORATE THE REQUIREMENTS OF AS/NZS 3000 AND ENERGEX.
- 26. ALL MILD STEEL PIPE TO BE SINTAKOTED.
- 27. ALL FLANGES AND WELDED JOINTS TO BE PROTECTED WITH DENSO WRAPPING TAPE.

SOIL CLASSIFICATION

- 28. THE CONTRACTOR SHALL ASSESS SOIL CONDITIONS TO DETERMINE CLASSIFICATION IN ACCORDANCE WITH SEQ-WAT-1200-1
- IF THE CONTRACTOR ENCOUNTERS SOIL IN TRENCHES WITH AN ALLOWABLE BEARING PRESSURE OF LESS THAN 50kPg, THEY SHALL IMMEDIATELY CONTACT THE RPEQ AND AWAIT DIRECTION.

/ATER SERVICE ≤ 32mm ID

- 30. CONSTRUCT SMALL DIAMETER PROPERTY SERVICES TO SEQ-WAT-1107-1 AND 1107-3.
 31. PROVIDE DN40PE (OR DN32 CU) WATER SERVICES FOR ROAD CROSSINGS SERVICING TWO
- PROVIDE DNAOPE (OR DN32 CU) WATER SERVICES FOR ROAD CROSSINGS SERVICING TWO DWELLINGS. PROVIDE DN32PE (OR DN25 CU) WATER SERVICES FOR ROAD CROSSINGS SERVICING A SINGLE DWELLING. IF THE LONGTERM STATIC HEAD OF THE PROPERTY SERVICE IS LESS THAN 350 KPA (35M) OR IF PRIVATE BOOSTER IS REQUIRED, THE MINIMUM SIZE OF PROPERTY SERVICE SHALL BE 32mm ID.
- 2. WATER METERS LESS THAN OR EQUAL TO DN25, SUPPLIED AT THE DEVELOPER'S COST, ARE TO BE INSTALLED AT THE SERVICE POINT OF EACH LOT IN ACCORDANCE WITH
- 33. WATER METERS GREATER THAN DN25, SUPPLIED AT THE DEVELOPER'S COST, ARE TO BE INSTALLED AT THE SERVICE POINT OF EACH LOT IN ACCORDANCE WITH QUU-WAT-002 AND DILLI-WAT-003.
- 34. CONTRACTOR TO PROVIDE METER NUMBERS AND READINGS FOR NEW AND RECLAIMED METERS.

- 35. ALL DISUSED SERVICES SHALL BE PLUGGED AT THE MAIN AND FERRULE CLOSED OR TAPPING BAND REMOVED.
- PROPOSED AND EXISTING WATER METER BOXES TO BE FREE OF DIRT AND DEBRIS PRIOR TO PLAN SEALING.

WATER SERVICE > 32mm ID

- 37. UNRESTRICTED ACCESS FROM THE STREET FRONTAGE OF THE SITE MUST BE PROVIDED TO THE WATER METER AT ALL TIMES FOR READING AND MAINTENANCE PURPOSES.
- 38. CONTRACTOR TO PROVIDE METER NUMBERS AND READINGS FOR NEW AND RECLAIMED METERS.
 39. LARGE DIAMETER SERVICES SHALL BE DISUSED BY REMOVING ANY PROPERTY SERVICE
- PIPEWORK AT THE POINT OF CONNECTION TO THE MAIN (INCLUDING VALVE), AND INSTALLING A BLANK FLANGE DIRECTLY ON THE TEE (OR OTHERWISE REMOVE THE TEE ALTOGETHER AND REPLACE WITH STRAIGHT PIPE).

TESTING AND CONNECTING

- 40. CONSTRUCT TEST POINTS TO SEQ.-WAT-1410-1 AT THE ENDS OF ALL NEW MAINS BEFORE THE SCOUR AND WHERE REQUIRED FOR COMMISSIONING PURPOSES. URBAN UTILITIES PREFERENCE IS TO AVOID TAPPING BANDS FOR TEST POINTS AND PROVIDE EITHER A TEMPORARY (RESTRAINED) DUCKFOOT HYDRANT OR FLANGED SHORT PIPE WITH A TEMPORARY TAPPED BLANK FLANGE. TESTING AGAINST LIVE MAINS AND VALVES IS NOT PERMITTED.
 41. TESTING LOCATIONS AND TEMPORARY FITTINGS ARE REQUIRED ON SERVICES OVER 10m LONG
- TESTING LOCATIONS AND TEMPORARY FITTINGS ARE REQUIRED ON SERVICES OVER 10m UNLESS APPROVED IN WRITING FOR WORKS TO BE UNDERTAKEN AS LIVE WORKS.
- 42. WHEN JOINING TO EXISTING UNRESTRAINED PIPELINES, PROVIDE A DICL SHORT PIPE WITH THRUST FLANGE AND THRUST BLOCK. BOLT ON UNI FLANGES SHALL NOT BE USED AS THRUST FLANGES. THRUST (PUDDLE) FLANGES SHALL BE AN APPROVED PREFABRICATED DICL/SCL SHORT PIPE WITH PREFABRICATED THRUST FLANGE.
- 43. AC MAINS SHALL BE REPLACED COLLAR-COLLAR. REFER TO URBAN UTILITIES DOCUMENTS PR0377, REF204 AND SWMS10 FOR SAFE HANDLING AND REMOVAL OF MATERIALS THAT CONTAIN ASBESTOS.
- 44. ALL LIVE WORKS TO BE UNDERTAKEN BY THE CONTRACTOR IN ACCORDANCE WITH A VALID NETWORK ACCESS PERMIT. WORKS TO BE DONE UNDER THE SUPERVISION OF THE CERTIFYING RPEQ AND URBAN UTILITIES AT THE DEVELOPERS EXPENSE.
- 45. LIVE WORKS MAY NOT COMMENCE UNTIL ALL RELEVANT TEST CERTIFICATES HAVE BEEN PROVIDED TO AND ACCEPTED BY URBAN UTILITIES AND HCE ENGINEERS AND ALL ADJOINING WORKS ARE TO HAVE HAVE BEEN ACCEPTED BY URBAN UTILITIES.
- 46. PRE-CHLORINATED FITTINGS SHALL BE USED FOR WATER SUPPLY LIVE-WORKS CONNECTIONS

MISCELLANEOUS

- 47. INSTALL PAVEMENT MARKERS TO SEQ-WAT-1300-1 AND 1300-2.
- 48. SERVICE CONDUITS SHALL EXTEND 300mm BEYOND ALL EXISTING OR PLANNED CONCRETE. FOOTPATHS, BIKEWAYS AND OTHER HARD STANDING AREAS AND INSTALLED IN ACCORDANCE WITH THE SEQ WATER SUPPLY CODE.
- 49. IT IS THE CONTRACTORS RESPONSIBILITY TO CONTACT 'DIAL BEFORE YOU DIG' PH.1100 FOR THE LOCATION OF EXISTING PUBLIC UTILITIES PRIOR TO EXCAVATION. ANY DAMAGE CAUSED TO EXISTING PUBLIC UTILITIES BY THE CONTRACTOR WILL BE REPAIRED BY THE RELEVANT AUTHORITY AT THE CONTRACTORS EXPENSE.

REHABILITATION

50. ALL DISTURBED AREAS TO BE REINSTATED TO THEIR ORIGINAL CONDITION.

VEGETATION PROTECTION

- TREES LOCATED ALONG THE FOOTPATH SHALL BE TRANSPLANTED PRIOR TO CONSTRUCTION, OR REPLACED IF DESTROYED.
- 52. WHEN WORKING WITHIN 4m OF TREES, RUBBER OR HARDWOOD, GIRDLES SHALL BE CONSTRUCTED WITH 1.8m BATTENS CLOSELY SPACED AND ARRANGED VERTICALLY FROM GROUND LEVEL. GIRDLES MUST BE STRAPPED TO TREES PRIOR TO CONSTRUCTION AND REMAIN LINITY. COMPLETION.
- 53. TREE ROOTS SHALL BE TUNNELLED UNDER, RATHER THAN SEVERED. IF ROOTS ARE SEVERED THE DAMAGED AREA SHALL BE TREATED WITH A SUITABLE FUNGICIDE. CONTACT RELEVANT ARRORIST FOR FURTHER ADVICE.
- ARBORIST FOR FORTHER ADVICE.

 54. ANY TREE LOPPING REQUIRED SHALL BE UNDERTAKEN BY AN APPROVED ARBORIST.

THESE WORKS ARE CONSIDERED MINOR WORKS AND WORKS ARE TO BE CONSTRUCTED BY A PRIVATE CONTRACTOR. INSPECTIONS ARE TO BE ARRANGED BY CONTACTING THE ENDORSED MINOR WATER AND SEWER PROVIDER IDENTIFIED ON THIS PLAN (HCE ENGINEERS). FOR AS CONSTRUCTED PLANS THE CONTRACTOR IS TO CONTACT HCE ENGINEERS (3829 1399) 7 DAYS PRIOR TO THE WORKS COMMENCING.

CERTIFICATION SCHEME ENDORSED CONSULTANT
(PLANS SUBMITTED ARE TO URBAN UTILITIES
STANDARDS AND SATISFY THE WATER APPROVAL CONDITIONS)

WATER APPROVAL REFERENCE NUMBER 20-PNT-47501

ENDORSED CONSULTANT... HCE ENGINEERS


NOMINATED RPEQ: GREG HENWOOD RPEQ NO. 5317

RPEQ SIGNATURE DATE. 22.09.20

RPEQ CONTACT DETAILS..07..3829..1399.

KPEQ CONTACT DETAILS......

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HCE Engineers
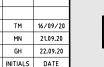
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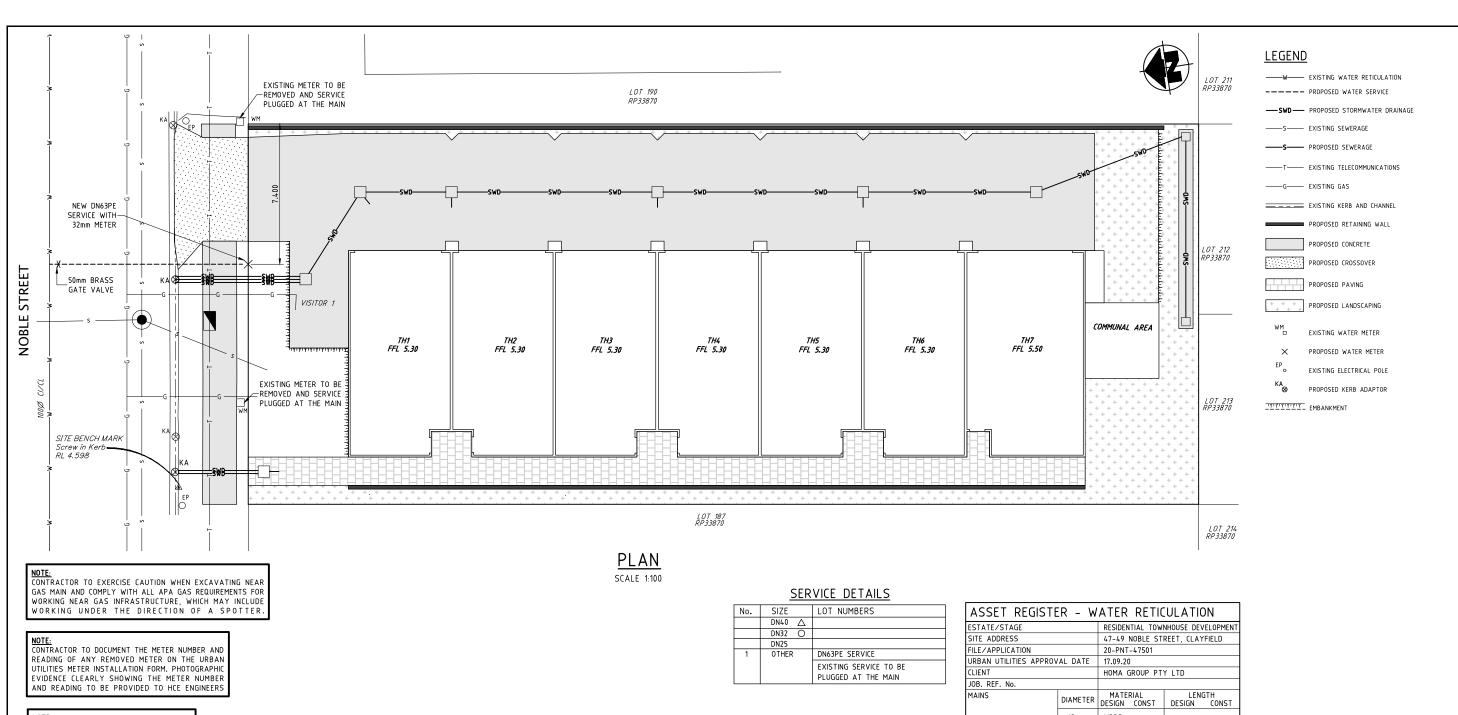
Urban Utilities

SHEET 1 OF 2

DRAWING NO.

47-49 NOBLE STREET, CLAYFIELD LOT 188-189 ON RP33870 WATER LOCALITY PLAN, DRAWING INDEX AND GENERAL NOTES

20191-W01



NOTE: UNRESTRICTED ACCESS FROM THE STREET FRONTAGE OF THE SITE MUST BE PROVIDED TO THE WATER METER AT ALL TIMES FOR READING AND MAINTENANCE PURPOSES

NOTE: PRESSURE TESTING NOT REQUIRED IF NEW SERVICE CONSTRUCTED FROM CONTINUOUS LENGTH OF PE PIPE

NOTE: FOR INTERNAL WATER SERVICES REFER TO CHILTON WOODWARD HYDRAULIC DESIGN DRAWINGS

NOTE: ROADS AND VERGES TO BE REINSTATED IN ACCORDANCE WITH BCC STD DRGS BSD-2042 AND BSD-2043

ESTATE/STAGE		DECIDE	NITIAL TOU	NUOLICE DEV	/ELODMEN	
SITE ADDRESS	RESIDENTIAL TOWNHOUSE DEVELOPMENT					
	47-49 NOBLE STREET, CLAYFIELD					
FILE/APPLICATION	20-PNT-47501					
URBAN UTILITIES APPROV	17.09.20					
CLIENT	HOMA GROUP PTY LTD					
JOB. REF. No.						
MAINS	DIAMETER	MATE DESIGN	ERIAL CONST	LENGTH DESIGN CONST		
	63mm	MDPE		-		
	100mm	UPVC		_		
		MSCL		-		
		DICL		-		
	150mm	UPVC DICL		-		
	200mm	DICL		-		
SERVICES	DIAMETER	MATERIAL DESIGN CONST		LEN DESIGN	GTH CONST	
	DN25	PE		-		
	DN32	PE		-		
	DN40	PE		-		
	DN63	PE		10.220m		
	100	DICL		-		
	150	DICL		-		
METERS	DIAMETER	NUMBER				
	20	-				
	25	-				
	32	1				
	OTHER	-				

SCALE 1:100 (A1) (SCALE BEFORE REDUCTION)

THESE WORKS ARE CONSIDERED MINOR WORKS AND WORKS ARE TO BE CONSTRUCTED BY A PRIVATE CONTRACTOR. INSPECTIONS ARE TO BE ARRANGED BY CONTACTING THE ENDORSED MINOR WATER AND SEWER PROVIDER IDENTIFIED ON THIS PLAN (HCE ENGINEERS). FOR AS CONSTRUCTED PLANS THE CONTRACTOR IS TO CONTACT HCE ENGINEERS (3829 1399) 7 DAYS PRIOR TO THE WORKS COMMENCING.

CERTIFICATION SCHEME ENDORSED CONSULTANT
(PLANS SUBMITTED ARE TO URBAN UTILITIES
STANDARDS AND SATISFY THE WATER APPROVAL CONDITIONS)

WATER APPROVAL REFERENCE NUMBER 20-PNT-47501 ENDORSED CONSULTANT...HCE ENGINEERS

NOMINATED RPEQ: GREG HENWOOD RPEQ NO. 5317 DATE. 22.09.20

RPEQ SIGNATURE

RPEQ CONTACT DETAILS..07. 3829. 1399.

DRAWN A 22.09.20 ISSUED FOR COMMENT PASSED MN GH INDEX DATE REVISIONS DRAWN CHECKED PASSED



TM 16/09/20

MN 21.09.20

GH 22.09.20

INITIALS DATE

HECKED

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Urban Utilities

47-49 NOBLE STREET, CLAYFIELD LOT 188-189 ON RP33870 WATER RETICULATION PLAN

SCALE AS SHOWN SHEET 2 OF 2 SHEETS DRAWING NO. 20191-W02